

NOTES

A. AIR CONDITIONING AND VENTILATION SERVICES

1. INSULATED REFRIGERANT PIPEWORK IN CEILING VOID SHALL BE WRAPPED WITH VINYL TAPE AND LAID ON CABLE BASKET
2. INSULATED REFRIGERANT PIPEWORK THROUGH WALLS AND SLAB SHALL BE PROTECTED WITH CORRUGATED PVC PIPES (50-65mm DIAMETER)
3. CONDENSATE PIPEWORK SHALL BE 32mm INSULATED AND WRAPPED WITH VINYL TAPE
4. INSULATED REFRIGERANT PIPEWORK EXPOSED TO THE WEATHER SHALL BE WRAPPED WITH VINYL TAPE AND LAID ON CABLE BASKET
5. CONDENSATE DRAIN CONNECTIONS TO WP SHALL BE WITH DOUBLE TRAP
6. CONDENSATE SHALL BE DISCHARGED TO STORM DRAINAGE, WHERE THIS IS NOT FEASIBLE, CONDENSATE SHALL BE DISCHARGED INTO PURPOSED CONDENSATE PIT (300x300 PIT FILLED WITH GRANITE)
7. OUTDOOR UNITS FOR SINGLE SPLIT UNITS SHALL GENERALLY BE MOUNTED ON FACTORY FABRICATED BRACKET AND MOUNTED AS INDICATED ON THE DRAWINGS.
8. ANTIVIBRATION MOUNTING SHALL BE PROVIDED FOR OUTDOOR UNITS

WATER SERVICES

1. PIPEWORK FOR WATER SERVICES WITHIN THE BUILDINGS SHALL BE PPR PIPE & FITTINGS
2. ISOLATION VALVES SHALL BE PROVIDED FOR BRANCH PIPES FOR EACH BATHROOM & KITCHEN
3. WATER CLOSET, WASH BASIN AND SINKS SHALL ALL HAVE INDIVIDUAL ISOLATION VALVES
4. EXTERNAL WATER SUPPLY PIPEWORK SHALL BE HDPE
5. ISOLATING VALVES SHALL BE PROVIDED FOR EACH WATER METER

A. SOIL AND WASTE DRAINAGE SERVICES

1. SOIL AND WASTE RAINWATER PIPEWORK SHALL BE TO BS4514 TO 6BAR
2. FALLS SHALL BE PROVIDED FOR SOIL AND WASTE PIPEWORK AS APPROPRIATE
3. A MINIMUM OF 600MM COVER SHALL BE PROVIDED FOR BURIED PIPES PASSING THROUGH DRIVEWAYS
4. ROODING EYE SHALL BE PROVIDED AT THE GROUND FLOOR FOR ALL SOIL AND WASTE STACK PIPES.
5. ROODING EYE SHALL BE PROVIDED WHEREEVER THEIR IS A CHANGE OF DIRECTION OF SOIL AND WASTE PIPEWORK

B. RAINWATER DRAINAGE SERVICES

1. RAINWATER PIPEWORK SHALL BE TO BS4514 TO 6BAR

LPG SERVICES

1. UNDERGROUND (BURIED) PIPEWORK BETWEEN THE GAS CYLINDER AND THE BUILDING SHALL BE POLYETHYLENE COLOURED YELLOW
2. UNDERGROUND (BURIED) PIPEWORK SHALL HAVE A MINIMUM COVER OF 375MM AND SHALL BE PROTECTED BY CORRUGATED PVC PIPES
3. PIPEWORK WITHIN THE RISER DUCT AND THE BUILDINGS SHALL BE HARD DRAWN - STRAIGHT LENGTH COPPER PIPES & FITTINGS
4. WHERE PIPES PASSED THROUGH WALL/SLAB SLEEVES SHALL BE PROVIDED.
5. SLEEVES THROUGH WALL/SLAB SHALL BE SEALED WITH FIRE RESISTANCE MASTIC SEALANT

SYMBOL	DESCRIPTION
CV.	CEILING VOID.
FA.	FROM ABOVE.
FB.	FROM BELOW.
HL.	HIGH LEVEL.
HLB.	HIGH LEVEL BELOW.
LL.	LOW LEVEL.
TA.	TO ABOVE.
TB.	TO BELOW.
AP	ACCESS PANEL
CCU	CEILING CONCEALED UNIT
CH	COOKER HOOD
CSU	CEILING CASSETTE UNIT
CU	CONDENSING UNIT (SPLIT)
CU-VRV	CONDENSING UNIT (VRV)
CP	CONDENSATE PIPE
DTG	DOOR TRANSFER GRILLE
EL	EXTERNAL LOUVRE
EG	EXTRACT GRILLE
EV	EXTRACT VALVE
FAU	FRESH AIR UNIT
IEF	IN-LINE EXTRACT FAN
RG	RETURN GRILLE
RP	REFRIGERANT PIPE
SD	SUPPLY DIFFUSER
WEF	WALL EXTRACT FAN
WSU	WALL MOUNTED SPLIT UNIT
WU	WALL MOUNTED UNIT (VRV)

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HL.	HIGH LEVEL.
HLB.	HIGH LEVEL BELOW.
LL.	LOW LEVEL.
TA.	TO ABOVE.
TB.	TO BELOW.
CWS	COLD WATER SUPPLY
DRS	DRY RISER SERVICE
EWI	ELECTRIC WATER HEATER (30LTRS)
EWI	ELECTRIC WATER HEATER (50LTRS)
FHR	FIRE HOSE REEL
HRS	HOSE REEL SERVICE
HWS	HOT WATER SUPPLY
LV	LANDING VALVE
UEWH	UNDER COUNTER ELECTRIC WATER HEATER (10LTRS)

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HL.	HIGH LEVEL.
HLB.	HIGH LEVEL BELOW.
LL.	LOW LEVEL.
TA.	TO ABOVE.
TB.	TO BELOW.
FD	FLOOR DRAIN
RWMH	RAINWATER MANHOLE
RWP	RAINWATER PIPE
SP	SOIL PIPE
SWMH	SOIL WASTE MANHOLE
SWP	SOIL WASTE PIPE
VC	VENT COWL
VP	VENT PIPE
WMH	WASTE MANHOLE
WP	WASTE PIPE


SYMBOL	DESCRIPTION
CV.	CEILING VOID
FA.	FROM ABOVE.
FB.	FROM BELOW.
LL.	LOW LEVEL.
TA.	TO ABOVE.
TB.	TO BELOW.
DRS	DRY RISER SERVICE
FB	FIRE BLANKET
FE1	PORTABLE FIRE EXTINGUISHER
SKG	DRY POWDER
FHR	FIRE HOSE REEL
FHS	FIRE HOSE REEL SERVICES
GC	GAS CYLINDER
GP	GAS PIPE
LV	LANDING VALVE

LEGEND.	
SYMBOL.	DESCRIPTION.
—	PIPE AT LOW LEVEL.
—	PIPE AT HIGH LEVEL.
—	PIPE BURIED IN GROUND/HIDDEN BELOW.
WC.	WATER CLOSET. 20mm. WATER, 100mm. SOIL CONNECTIONS.
WB.	WASH BASIN 20mm. WATER, 32mm. WASTE CONNECTIONS.
SHW.	SHOWER 20mm. WATER, 40mm. WASTE CONNECTIONS.
BTH.	BATH 20mm. WATER, 40mm. WASTE CONNECTIONS.
SK.	KITCHEN SINK 20mm. WATER, 40mm. WASTE CONNECTIONS.
EWI & UEWH	ELECTRIC WATER HEATERS 20mm. WATER CONNECTIONS.


NO.	REVISIONS	DATE	BY
1	ISSUED FOR REVIEW	24 MAR 23	JA
2	ISSUED FOR REVIEW	28 MAY 23	CJM
3	ISSUED FOR REVIEW	24 MAY 23	CJM
4	ISSUED FOR REVIEW	01 SEPT 23	CJM
5	ISSUED FOR REVIEW	15 SEPT 23	CJM

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REFRIGERANT MATERIALS ARE SHOWN AS WORK
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SHEET CONTENT	PLUMBING LEGEND	SHEET NO.
		P M01
SCALE: NIS	CJM / DRAWN	FILE NAME: P987/M01
CHECKED: APPROVED	CJM / DATE	PROJ. NO.: P987

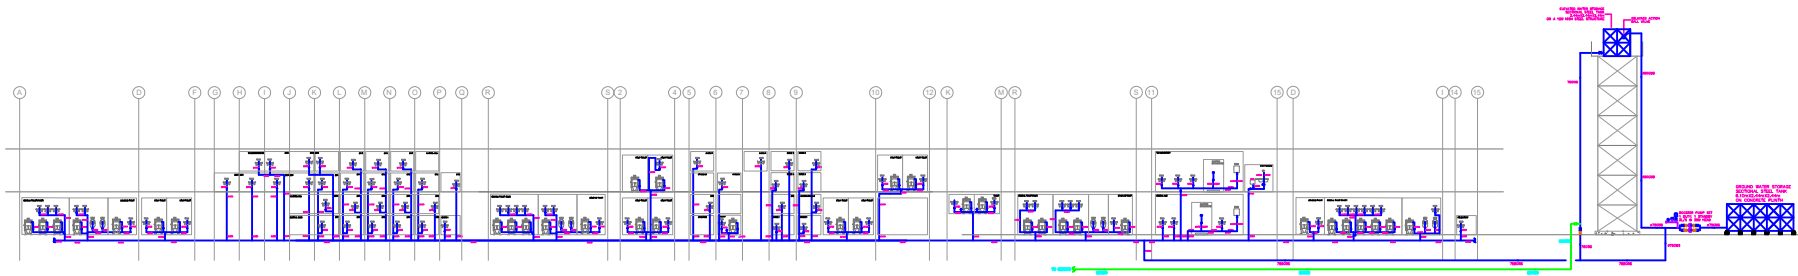



WATER SERVICES SCHEMATICS

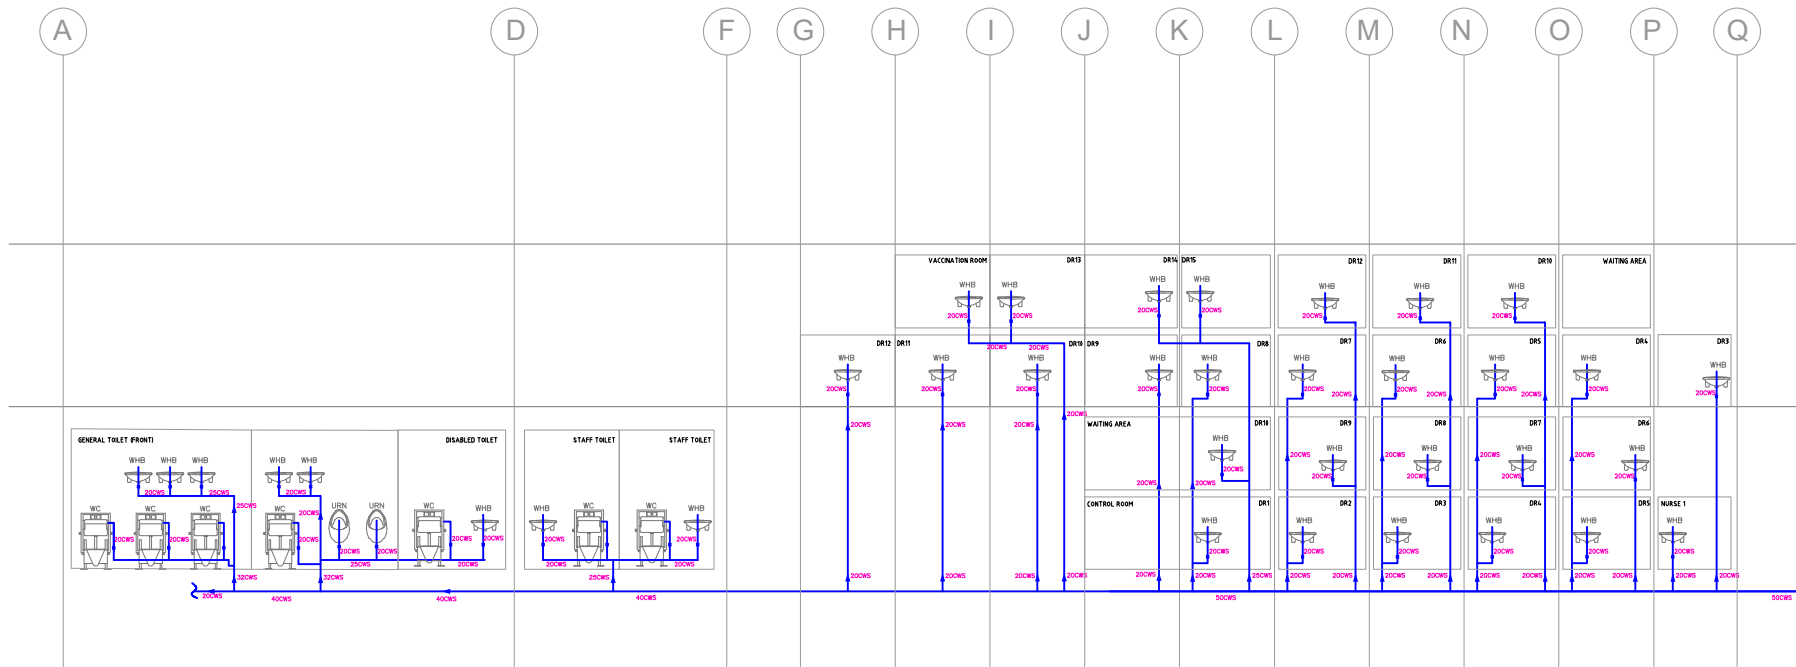


NO.	REVISIONS	DATE	BY
1	ISSUED FOR REVIEW	24 MAR 25	JIA
2	ISSUED FOR REVIEW	25 MAY 25	OLW
3	SITE PERMITS/REVISED	26 MAY 25	OLW
4	ISSUED FOR REVIEW	26 JUNE 25	OLW
5	ISSUED FOR REVIEW	01 SEPT. 25	OLW
6	ISSUED FOR REVIEW	15 SEPT. 25	OLW

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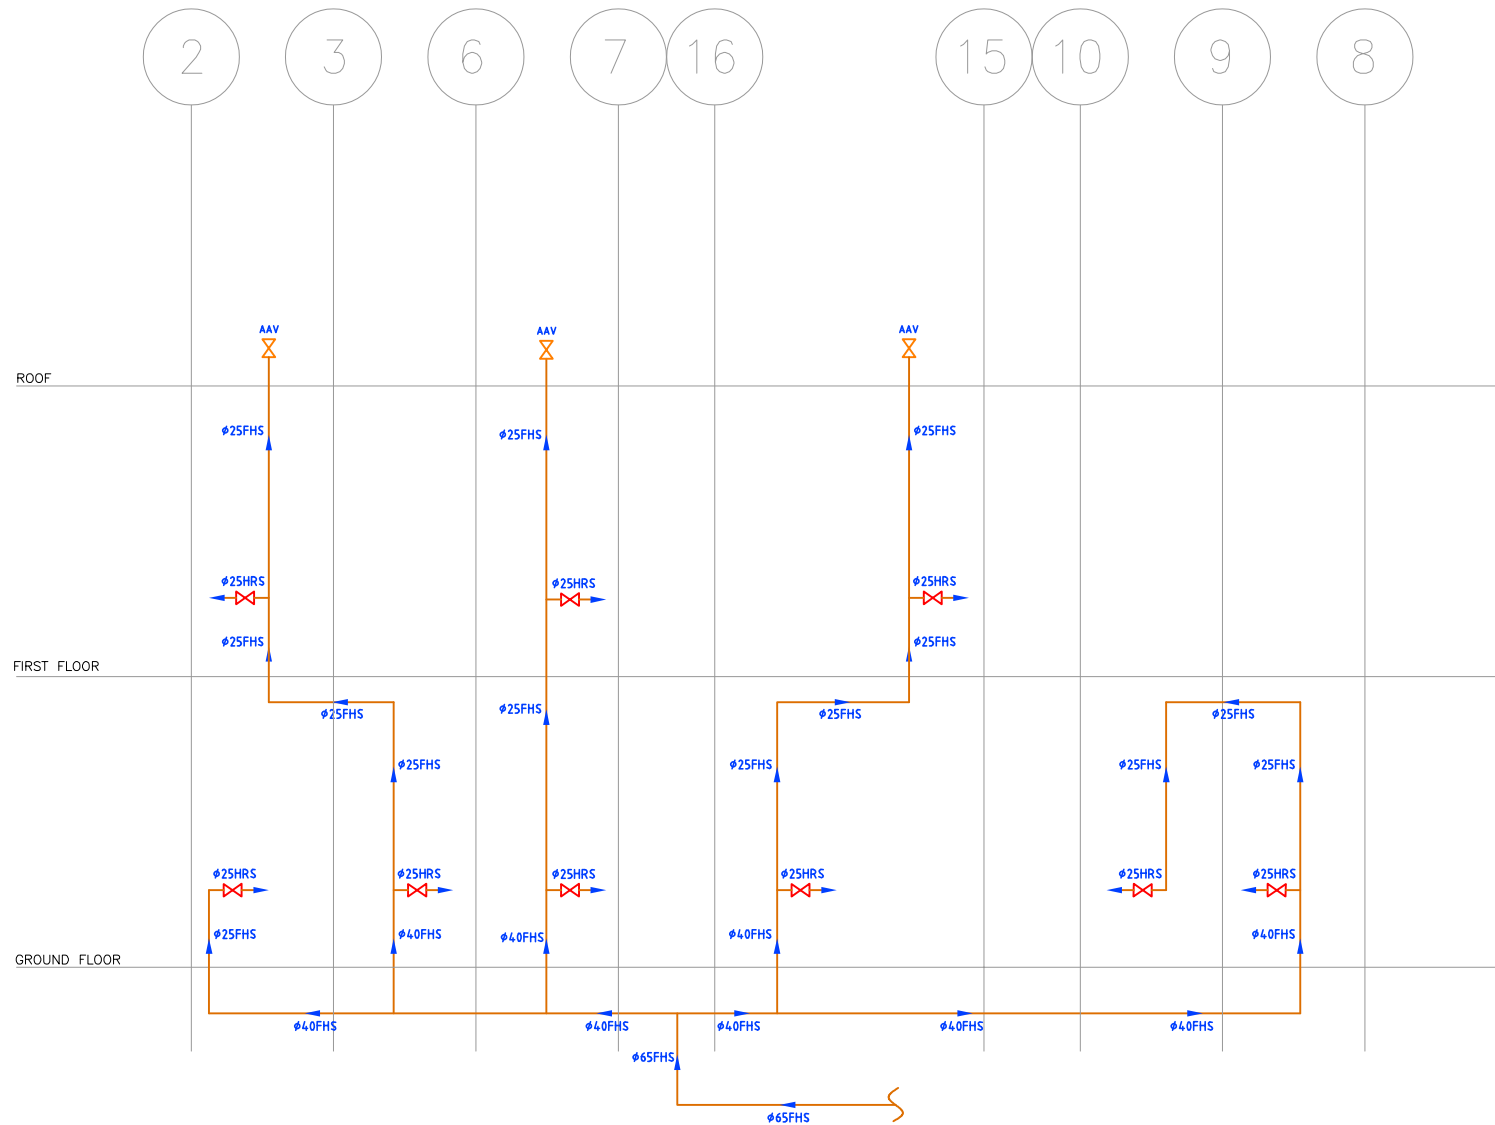


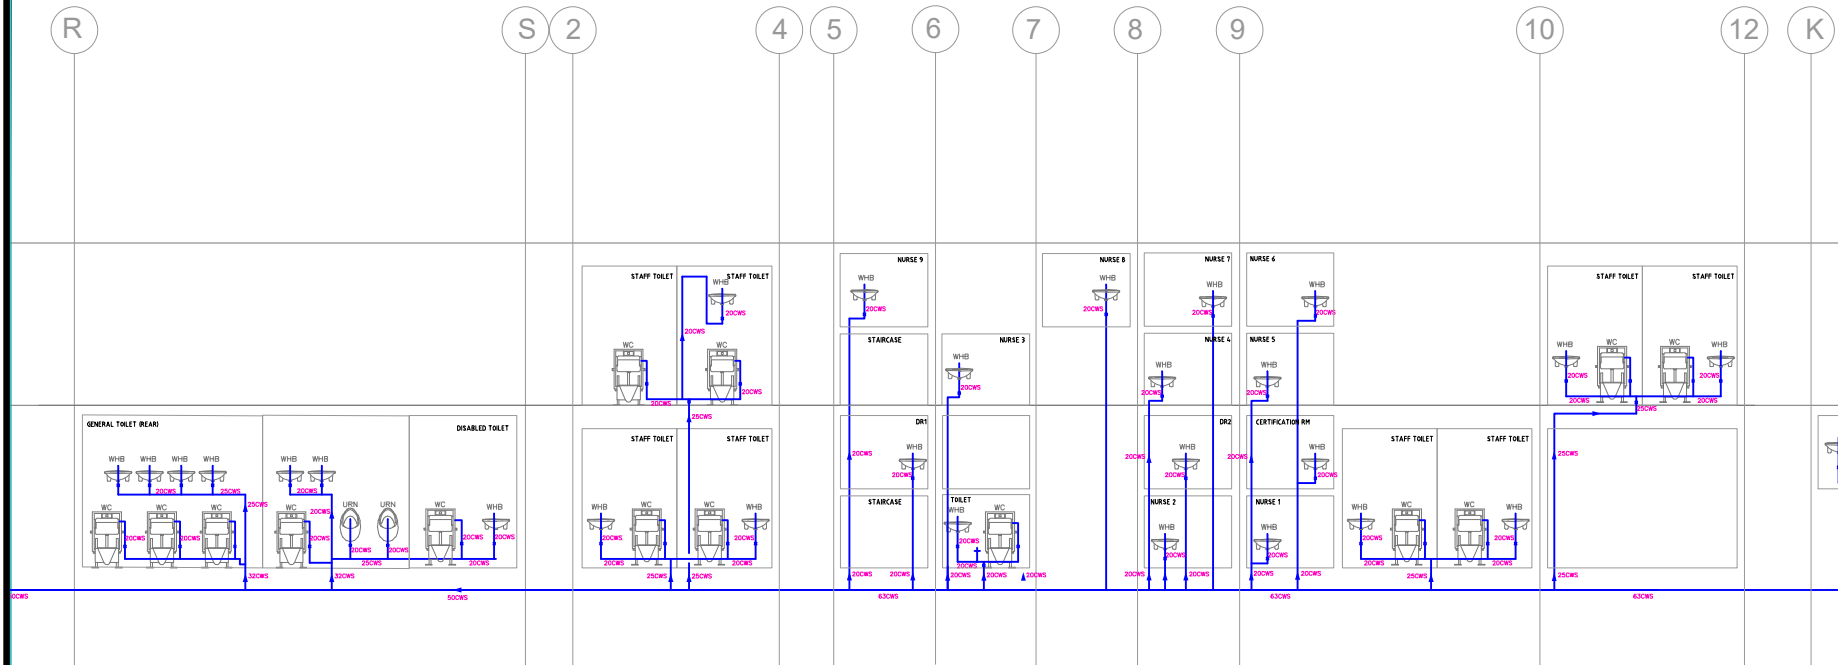

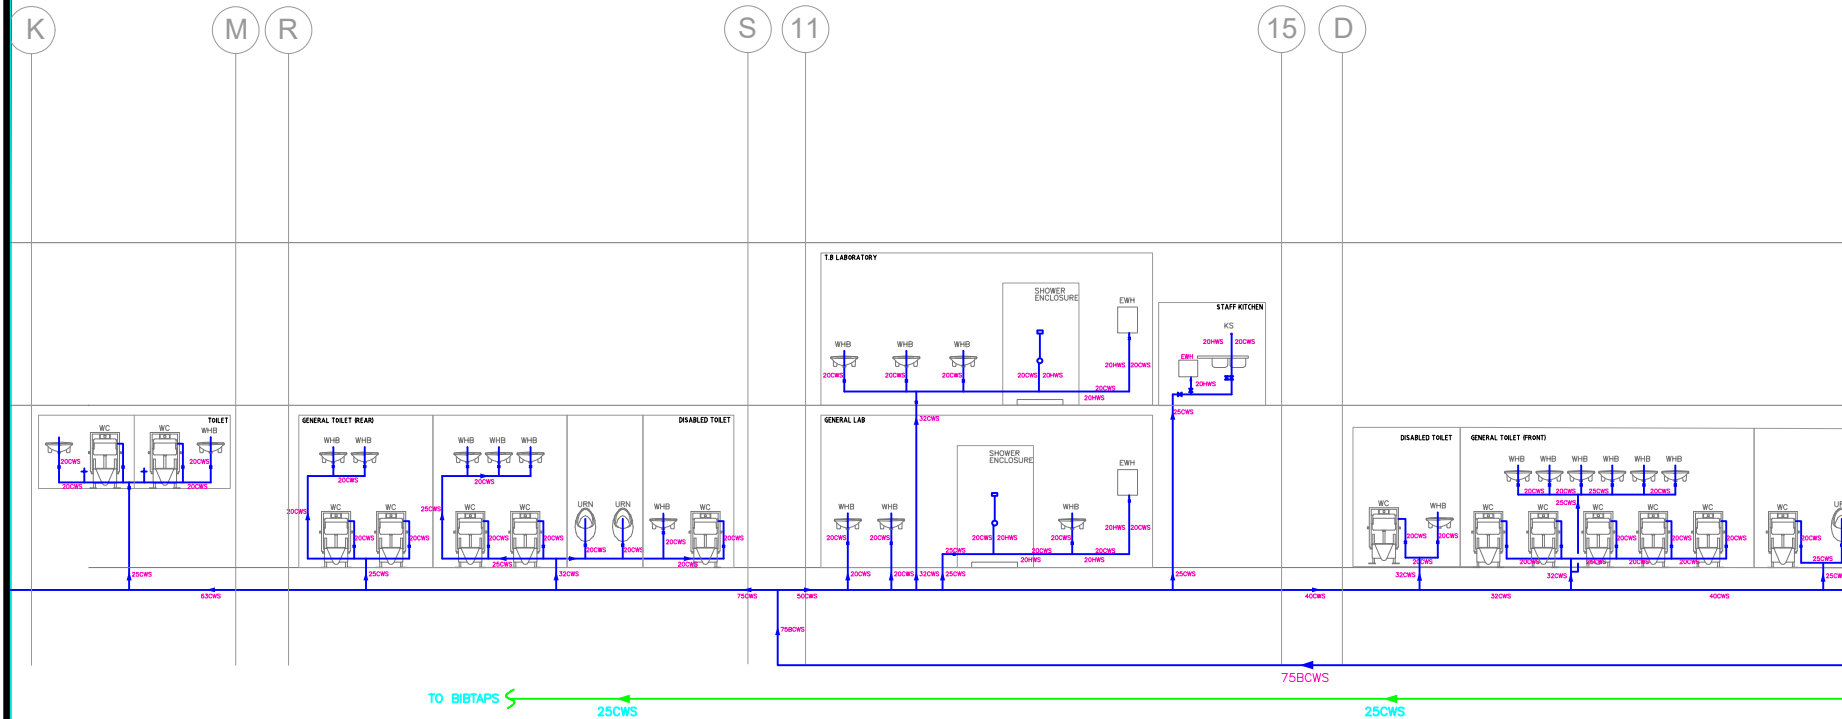NOTES
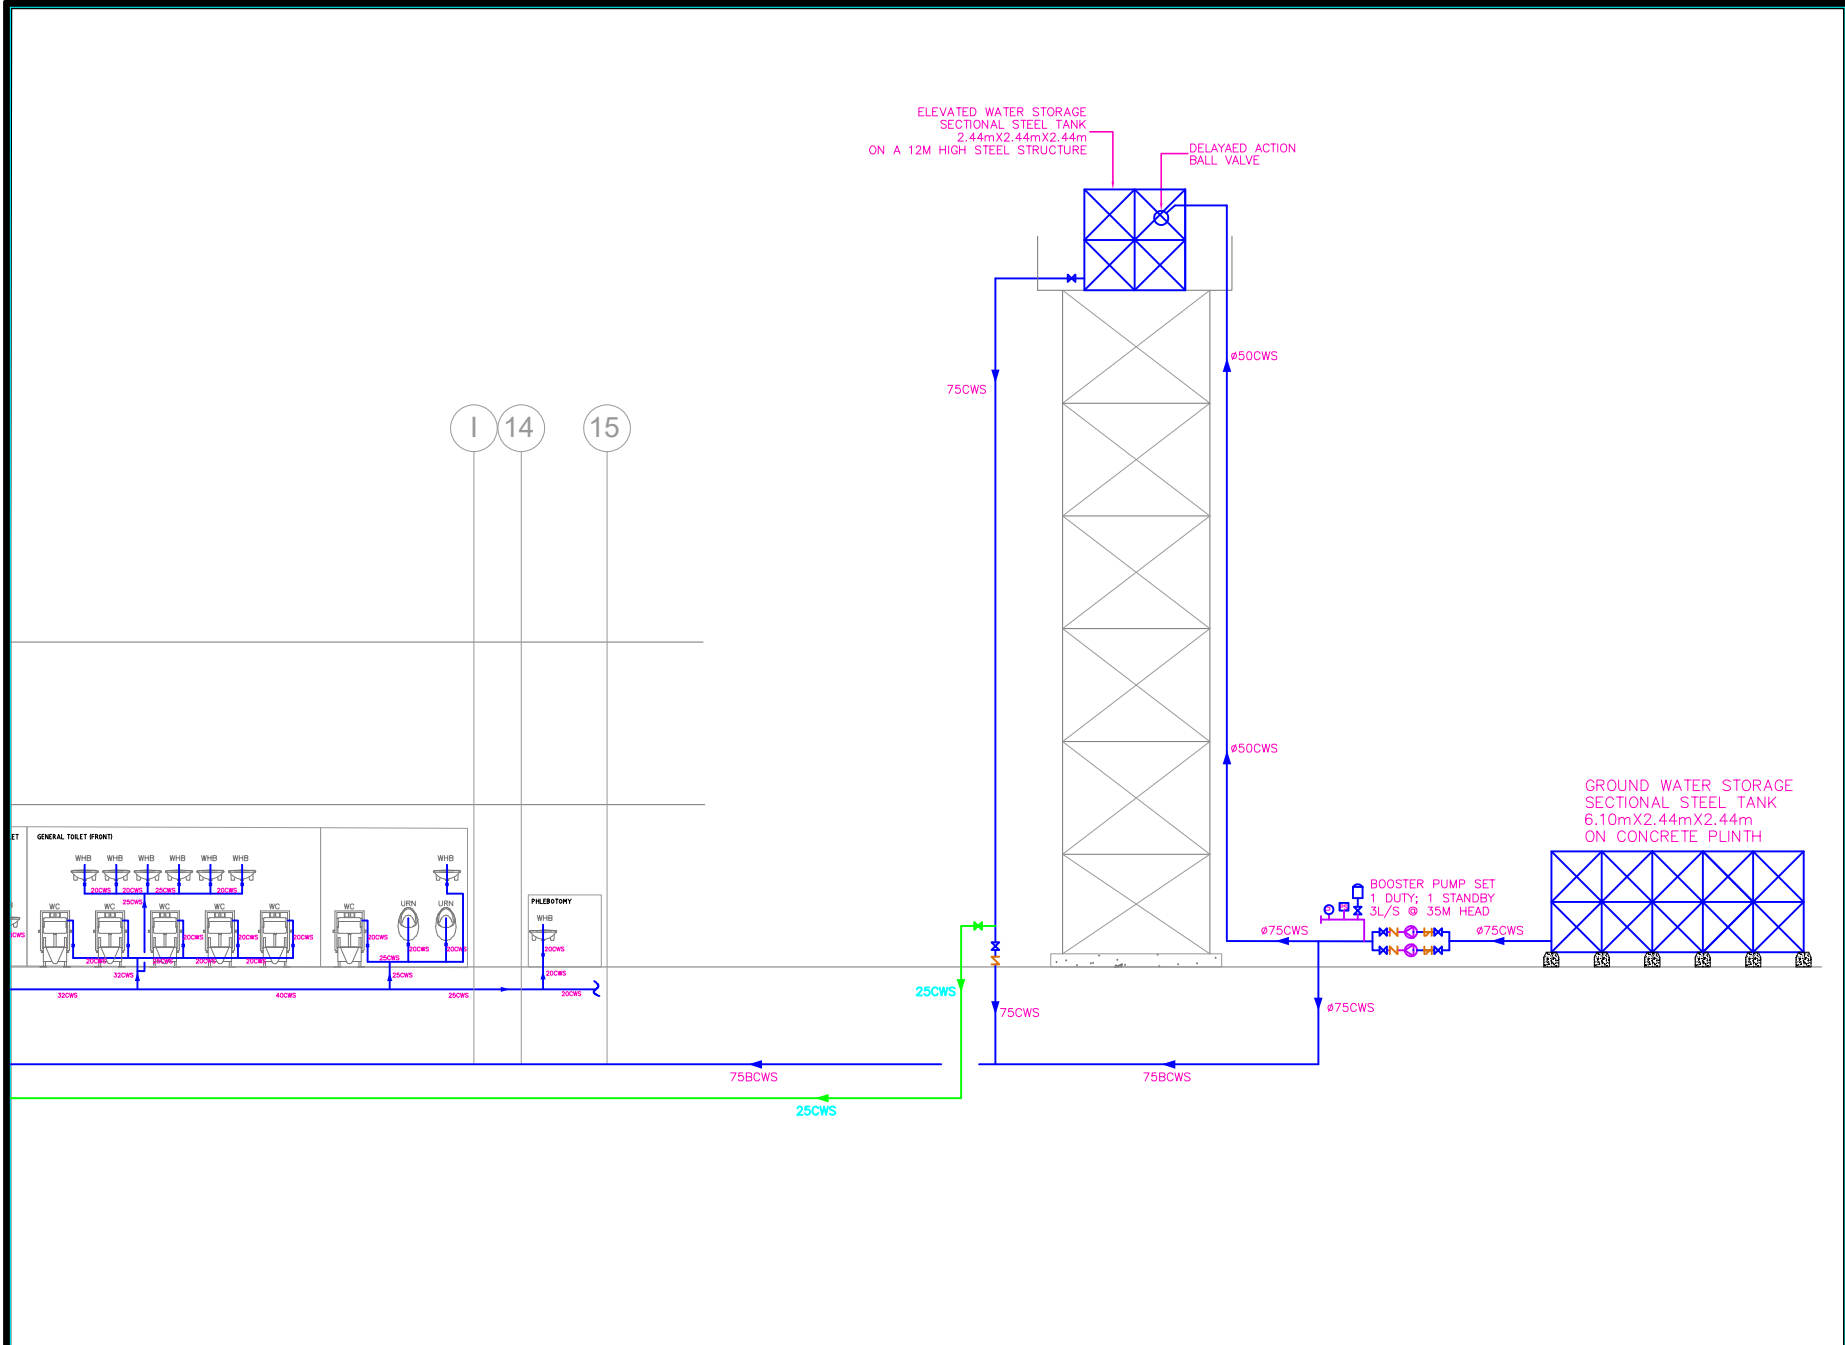
<div><div>Pinconsult Associates Limited</div><div>CHARTERED ENGINEERS & DEVELOPMENT CONSULTANTS 27/29, KING GEORGE V ROAD, ONIKAN LAGOS.</div></div>	ARCHITECT/ENGINEER	PROJECT / LOCATION	CLIENT	NO.	REVISIONS	DATE	BY	<div>IN ANY SCALE, ALL CONTRACTORS MUST CHECK ON SITE 1. ALL DIMENSIONS AND QUANTITIES SHOWN, ANY AMBIGUITY OR DISCREPANCIES MUST BE REFERRED TO THE ARCHITECTS BEFORE MATERIALS ARE ORDERED OR WORK STARTED. 2. THIS DRAWING IS COPYRIGHT AND MAY NOT BE REPRODUCED OR USED IN ANY WAY WITHOUT THE PERMISSION OF THE ARCHITECTS/ENGINEERS.</div>	SHEET CONTENT	SCHEMATICS - WATER SERVICES (6 OF 8)	SHEET NO.
	<div>ENGR. OLALEYE</div> <div>MICHAEL (ENGR) CORE REG. NO. 26174</div>	PROPOSED CONSTRUCTION & RENOVATION OF THE IOM HEALTH ASSESSMENT CENTRE (MHAC) ANNEX 3 LAGOS STATE	<div></div> <div>IOM</div> <div>IOM • OIM</div>	1	ISSUED FOR REVIEW	24 MAR 28	JIA		<div>SCALE: NS</div> <div>CHECKED: QJW DRAWN: QJW APPROVED: QJW DATE: P967/MJ06</div>	P	M06
				2	ISSUED FOR REVIEW	23 MAY 28	QJW				
				3	SITE PERIMETER UPDATED	24 MAY 28	QJW				
				4	ISSUED FOR REVIEW	28 JUNE 28	QJW				
				5	ISSUED FOR REVIEW	01 SEPT. 28	QJW				
				6	ISSUED FOR REVIEW	16 SEPT. 28	QJW				

NOTES



FIRE HOSEREEL SCHEMATICS

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 27/28, KING GEORGE V ROAD, ONIKAN LAGOS.

ARCHITECT/ENGINEER
 ENGR. OLALEYE
 MECHANICAL ENGINEER
 CORP REG. NO. 18/174


PROJECT / LOCATION
 PROPOSED CONSTRUCTION & RENOVATION
 OF THE IOM HEALTH ASSESSMENT
 CENTRE. (MHAC) ANNEX 3
 LAGOS STATE

CLIENT
 IOM
 IOM • OIM


NO.	REVISIONS	DATE	BY
1	ISSUED FOR REVIEW	24 MAY 20	AA
2	ISSUED FOR REVIEW	20 MAY 20	DAW
3	DATE FOR REVIEW	24 MAY 20	DAW
4	ISSUED FOR REVIEW	16 SEP 20	DAW

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SHEET CONTENT	PRELIMINARY SCHEMATICS	SHEET NO.
SCALE: NS	FILE NAME: P967/M07	P 107
CHECKED: OJW	DATE: 16 SEP 20	PROJ. NO. P967
APPROVED: OJW	DATE: 16 SEP 20	

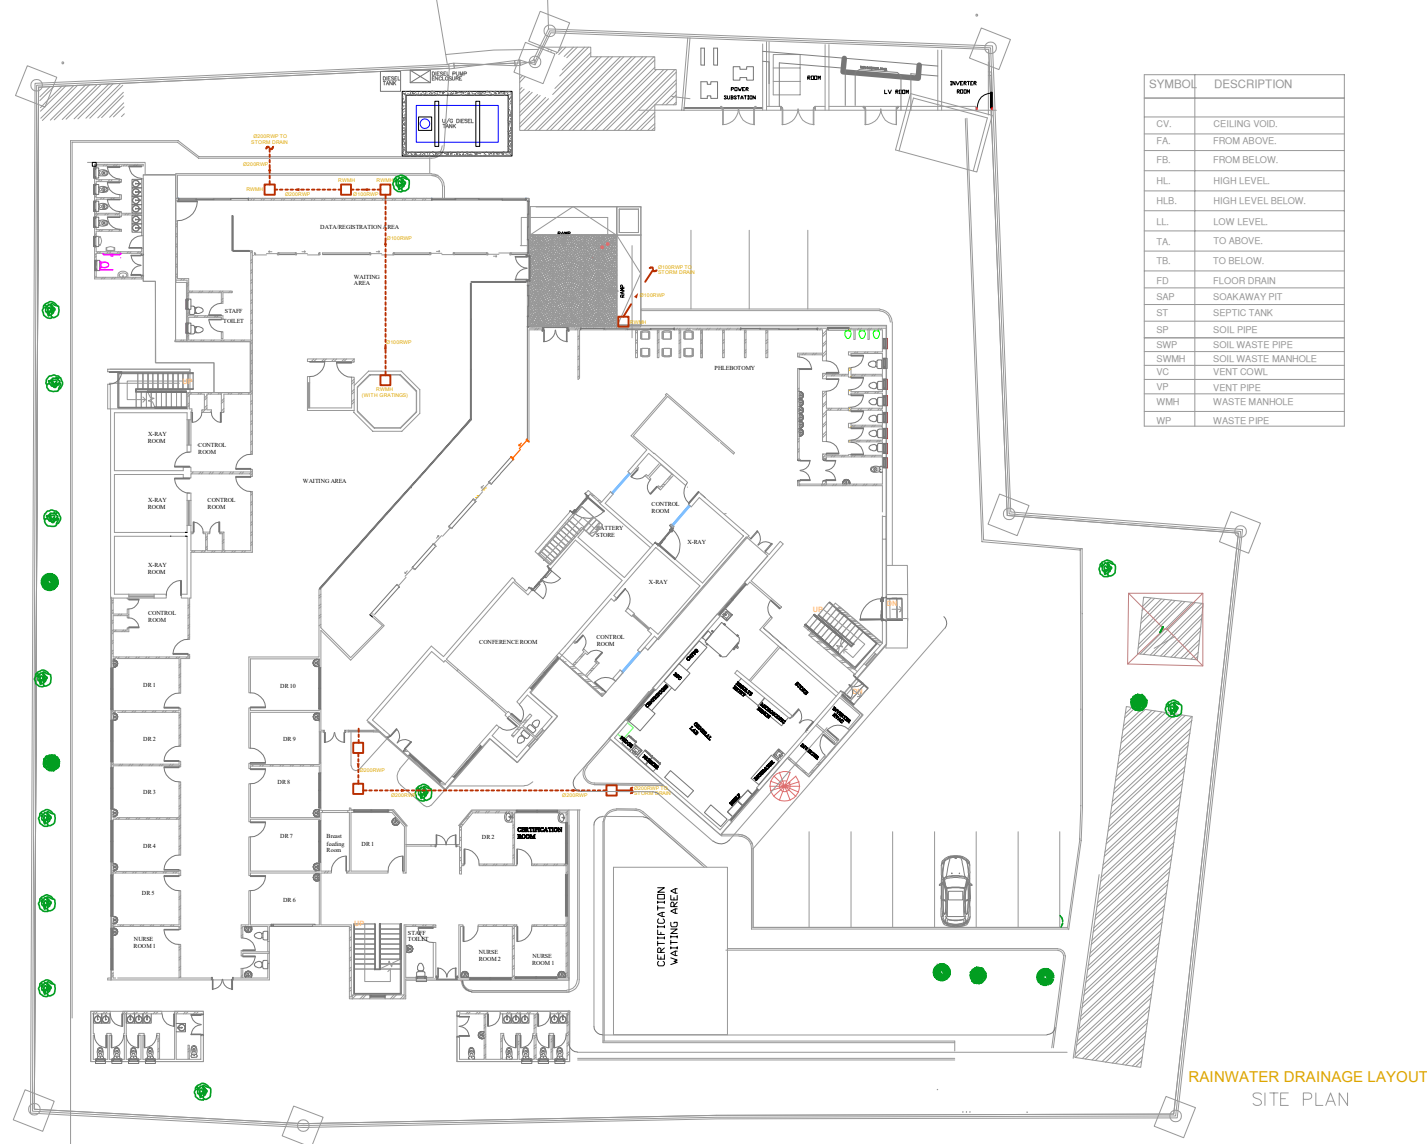

SYMBOL	DESCRIPTION
CV.	CEILING VOID.
FA.	FROM ABOVE.
FB.	FROM BELOW.
HL.	HIGH LEVEL.
HLB.	HIGH LEVEL BELOW.
LL.	LOW LEVEL.
TA.	TO ABOVE.
TB.	TO BELOW.
FD	FLOOR DRAIN
SAP	SOAKAWAY PIT
ST	SEPTIC TANK
SP	SOIL PIPE
SWP	SOIL WASTE PIPE
SWMH	SOIL WASTE MANHOLE
VC	VENT COWL
VP	VENT PIPE
WMH	WASTE MANHOLE
WP	WASTE PIPE

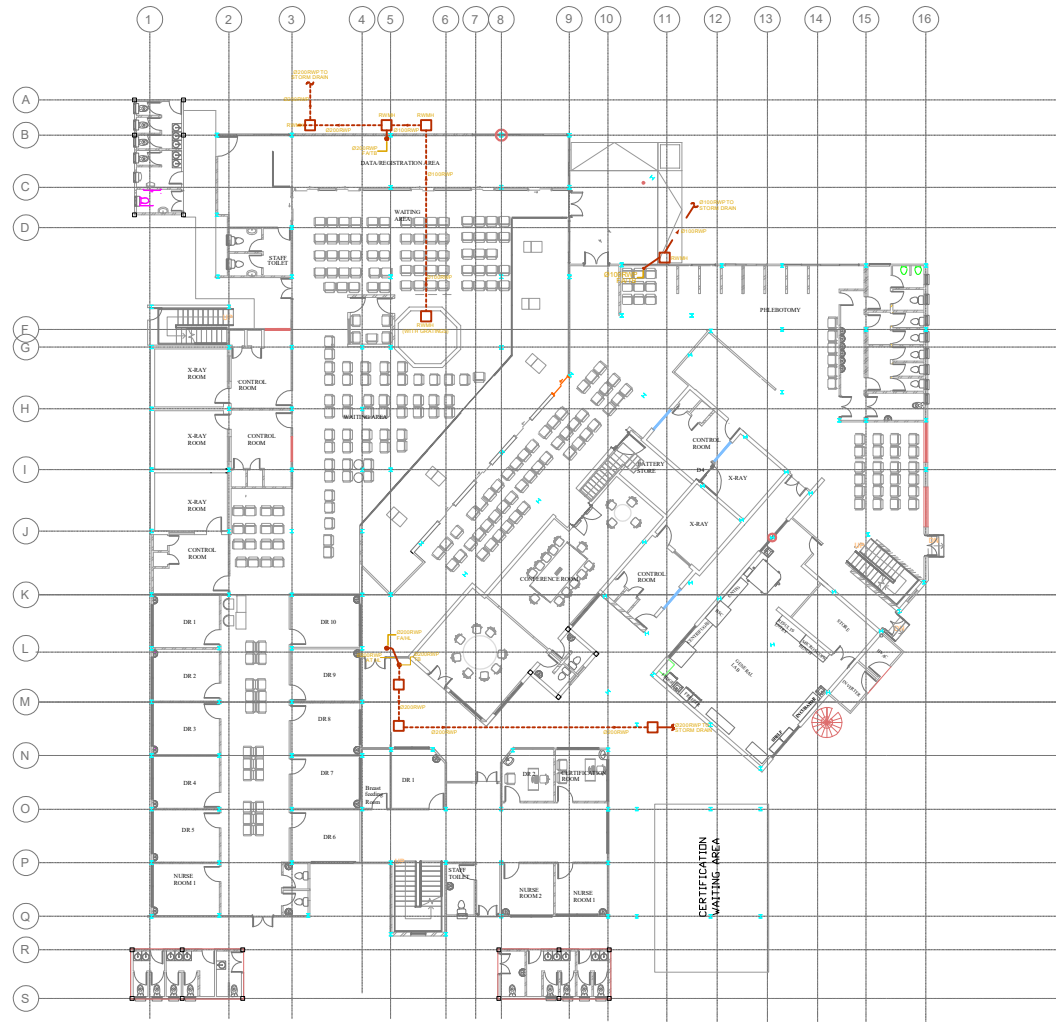


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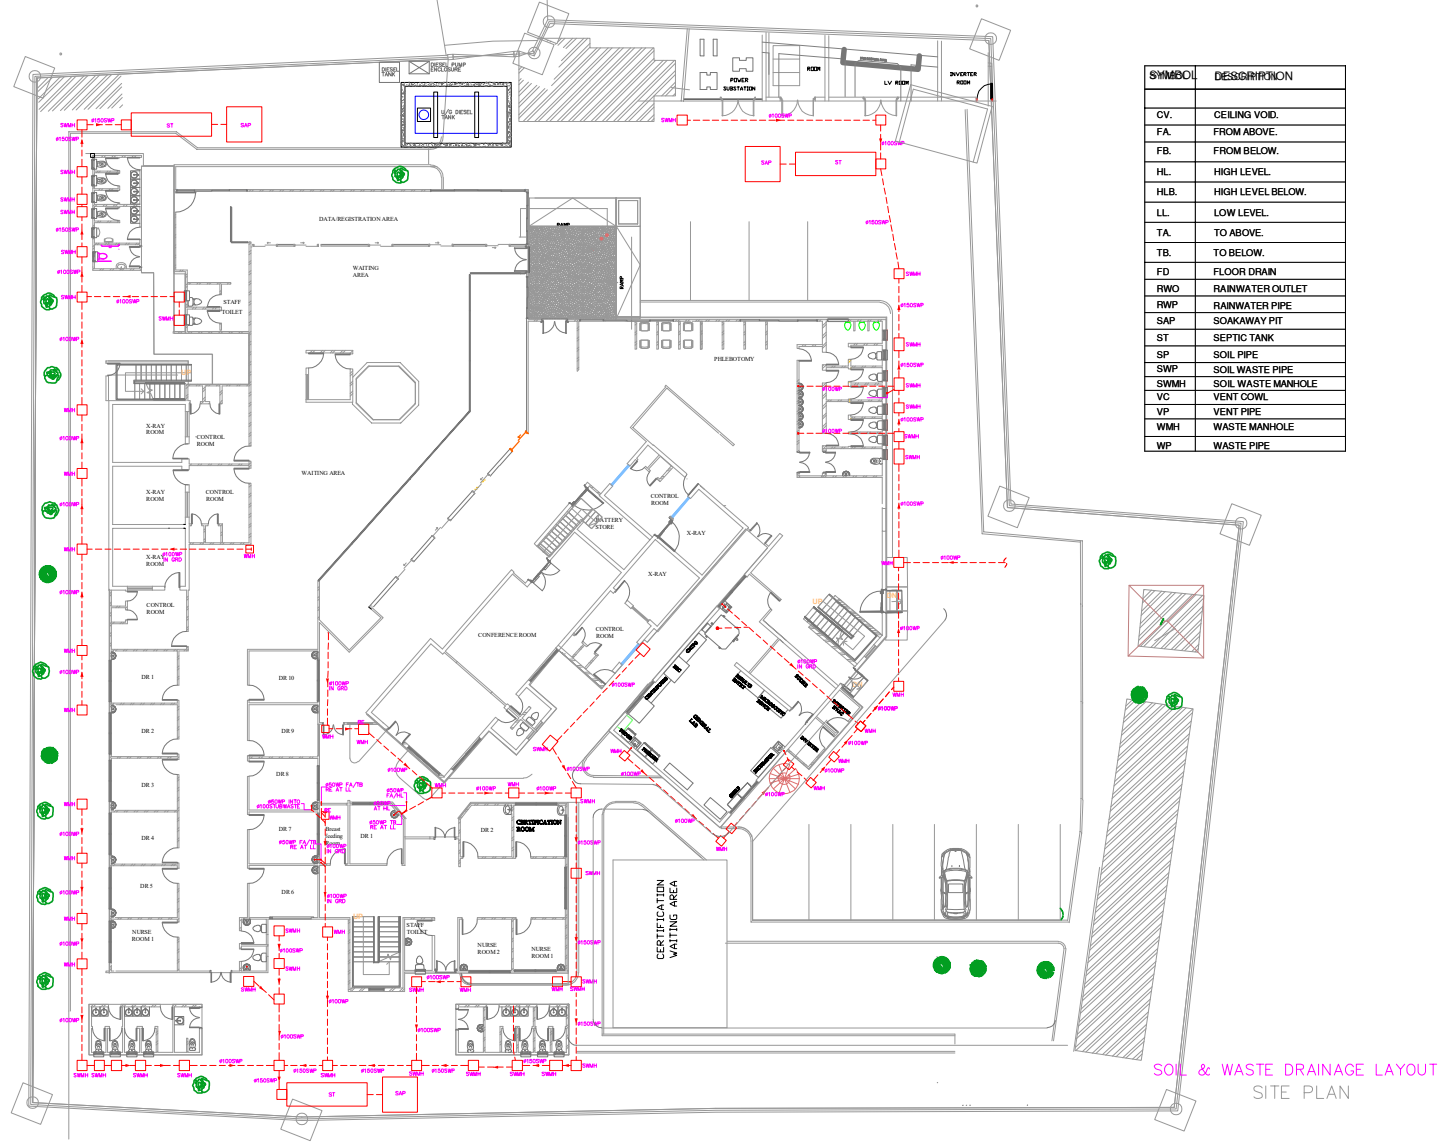
RAINWATER DRAINAGE LAYOUT
GROUND FLOOR

NO.	REVISIONS	DATE	BY
1	ISSUED FOR REVIEW	20 MAY 23	OLW
2	SITE PERIMETER UPDATED	24 MAY 23	OLW
3	ISSUED FOR REVIEW	26 JUNE 23	OLW
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5	ISSUED FOR REVIEW	01 SEPT. 23	OLW
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SWMH	
VC	
VP	
WMH	
WP	



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ARCHITECT/ENGINEER
ENGR. OLALEYE
MICHAEL, LINDSEY
CORP/REL. NO. 26/74

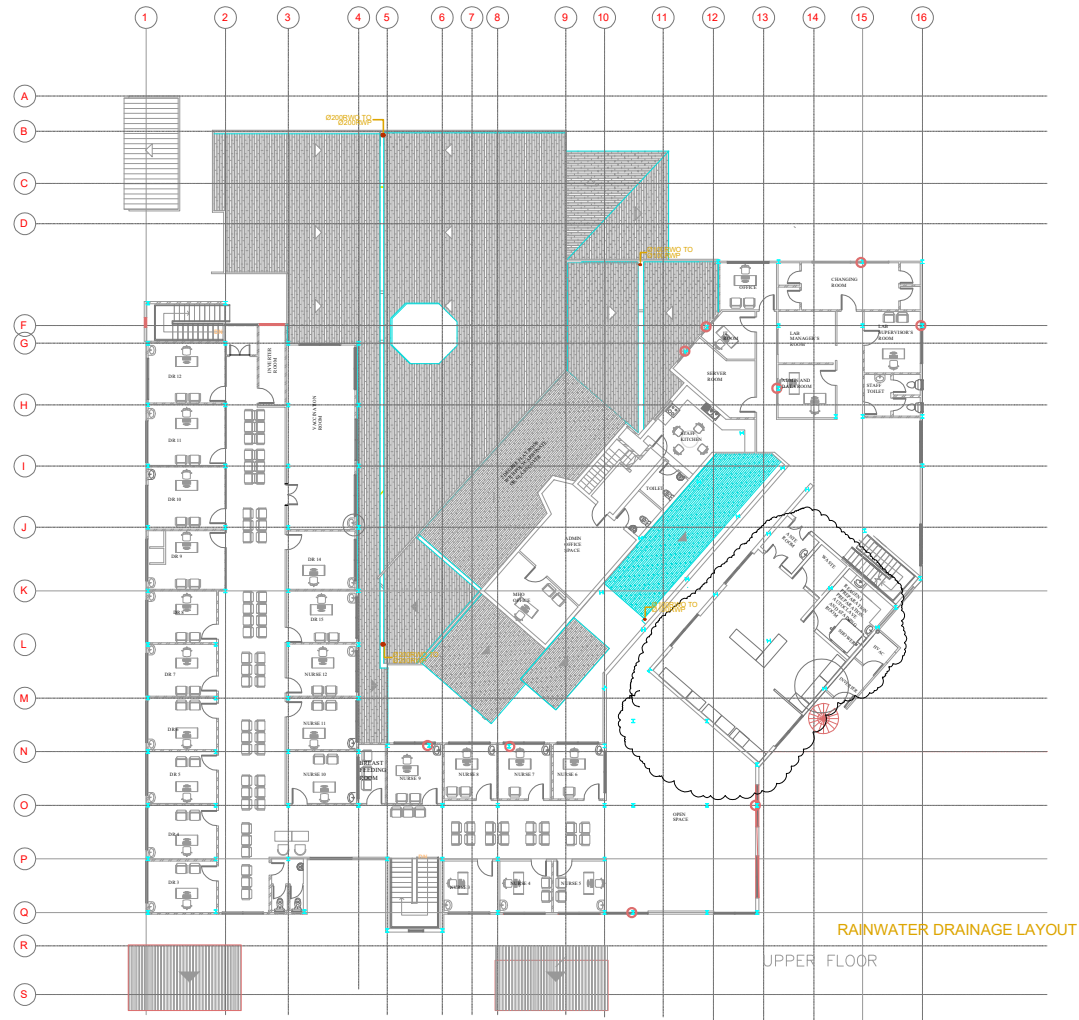PROJECT / LOCATION
**PROPOSED CONSTRUCTION & RENOVATION
OF THE IOM HEALTH ASSESSMENT
CENTRE (MHAC) ANNEX 3
LAGOS STATE**

CLIENT
 IOM
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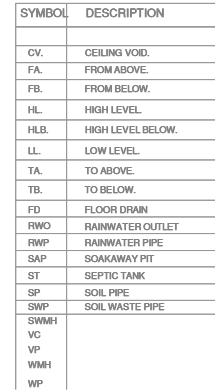
NO.	REVISIONS	DATE	BY
1	ISSUED FOR REVIEW	20 MAY 23	QJM
2	SITE PERIMETER UPDATED	24 MAY 23	QJM
3	ISSUED FOR REVIEW	26 JUNE 23	QJM
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6	ISSUED FOR REVIEW	16 SEPT. 23	QJM


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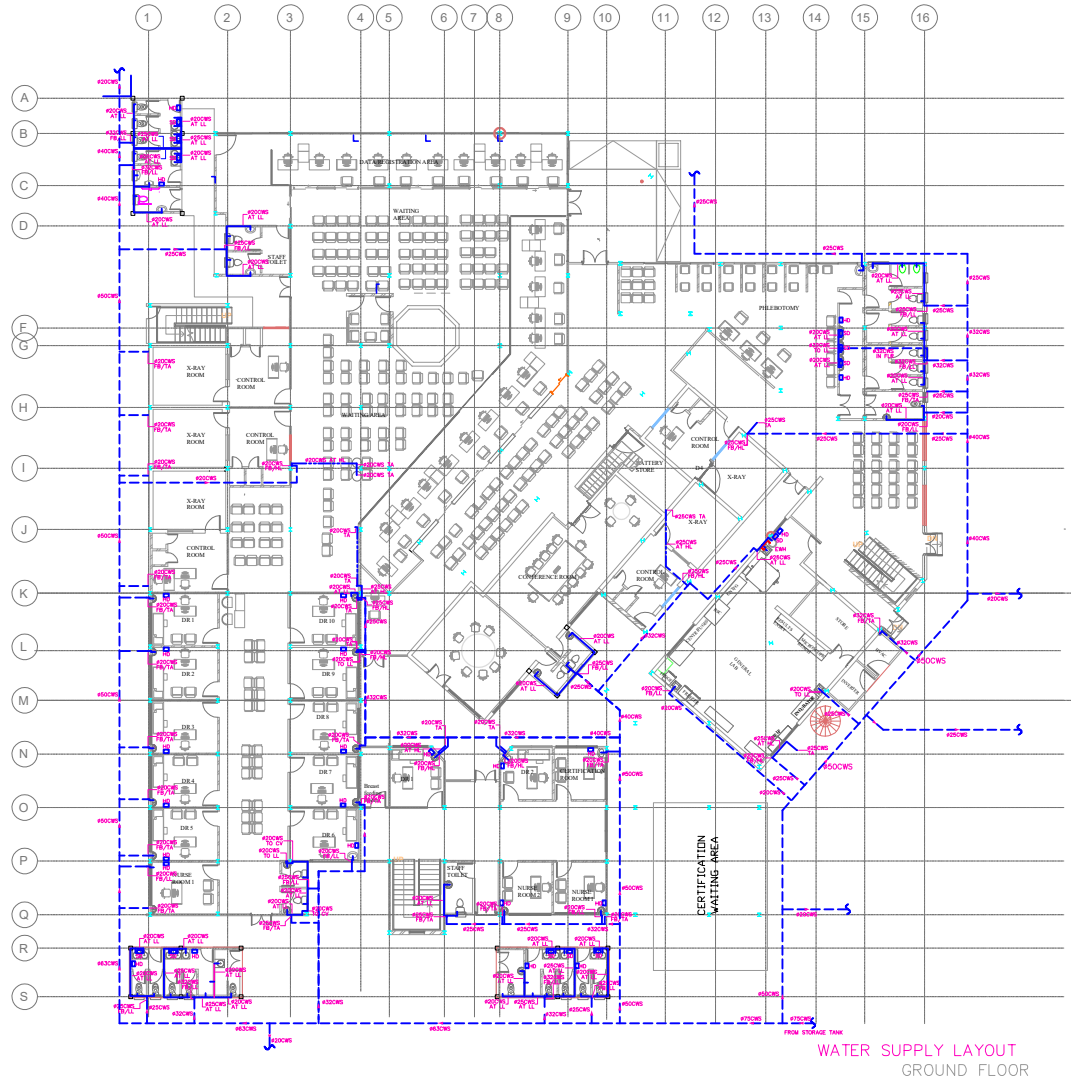
SHEET CONTENT	SITE PLAN - DRAINAGE	SHEET NO.
SCALE: NS	CHECKED: QJM APPROVED: QJM	FILENAME: P967/M/11 PROJ. NO.: P967



SYMBOL	DESCRIPTION
CV.	CEILING VOID.
FA.	FROM ABOVE.
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HL.	HIGH LEVEL.
HLB.	HIGH LEVEL BELOW.
LL.	LOW LEVEL.
TA.	TO ABOVE.
TB.	TO BELOW.
CE	CLEANING EYE
FD	FLOOR DRAIN
RE	RODDING EYE
RWO	RAINWATER OUTLET
RWP	RAINWATER PIPE
SAP	SOAKAWAY PIT
ST	SEPTIC TANK
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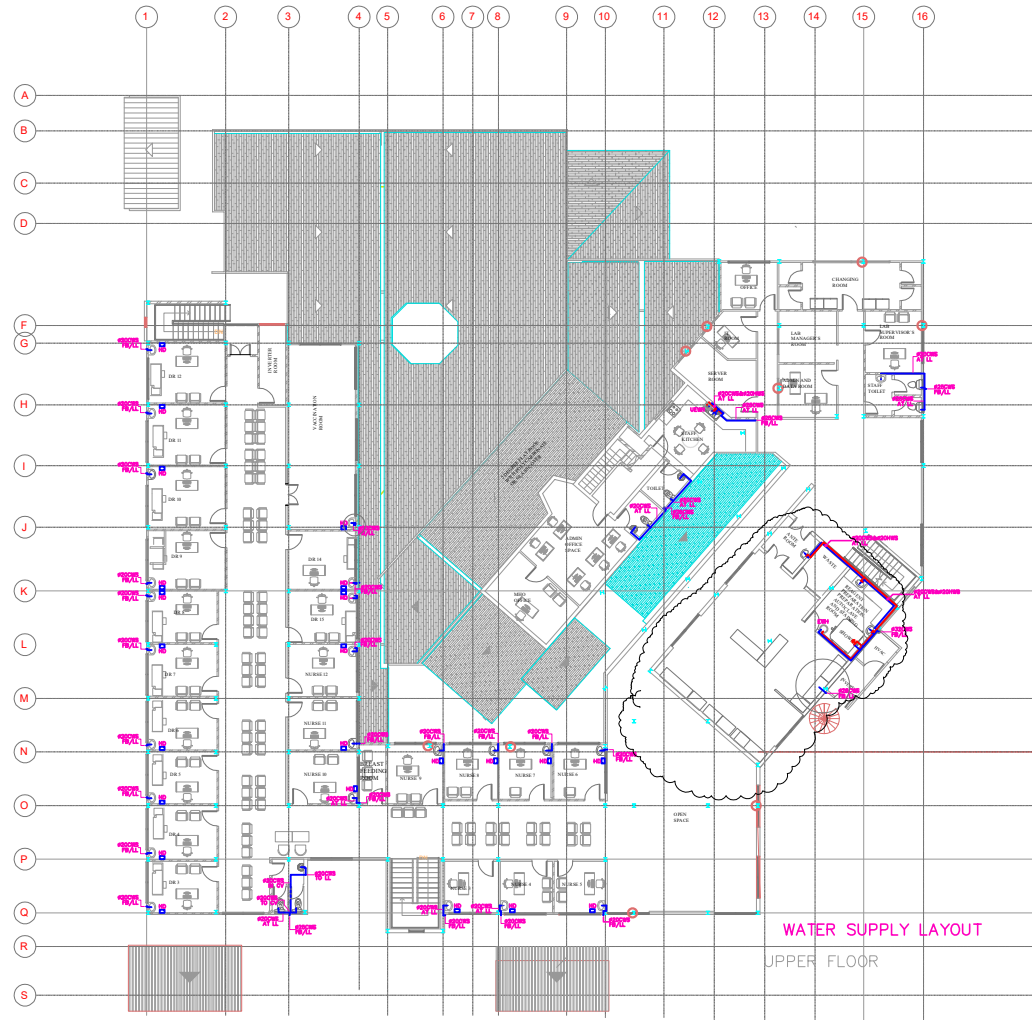
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TB.	TO BELOW.
CWS	COLD WATER SUPPLY
EWH	ELECTRIC WATER HEATER
HD	HAND DRYER
HWS	HOT WATER SUPPLY
SD	SOAP DISPENSER

WATER SUPPLY LAYOUT
GROUND FLOOR

NO.	REVISIONS	DATE	BY
1	ISSUED FOR REVIEW	24 MAY 23	JIA
2	ISSUED FOR REVIEW	20 MAY 23	QAW
3	ISSUED FOR REVIEW	28 JUNE 23	QAW
4	ISSUED FOR REVIEW	24 AUG 23	QAW
5	ISSUED FOR REVIEW	01 SEPT. 23	QAW
6	ISSUED FOR REVIEW	15 SEPT. 23	QAW

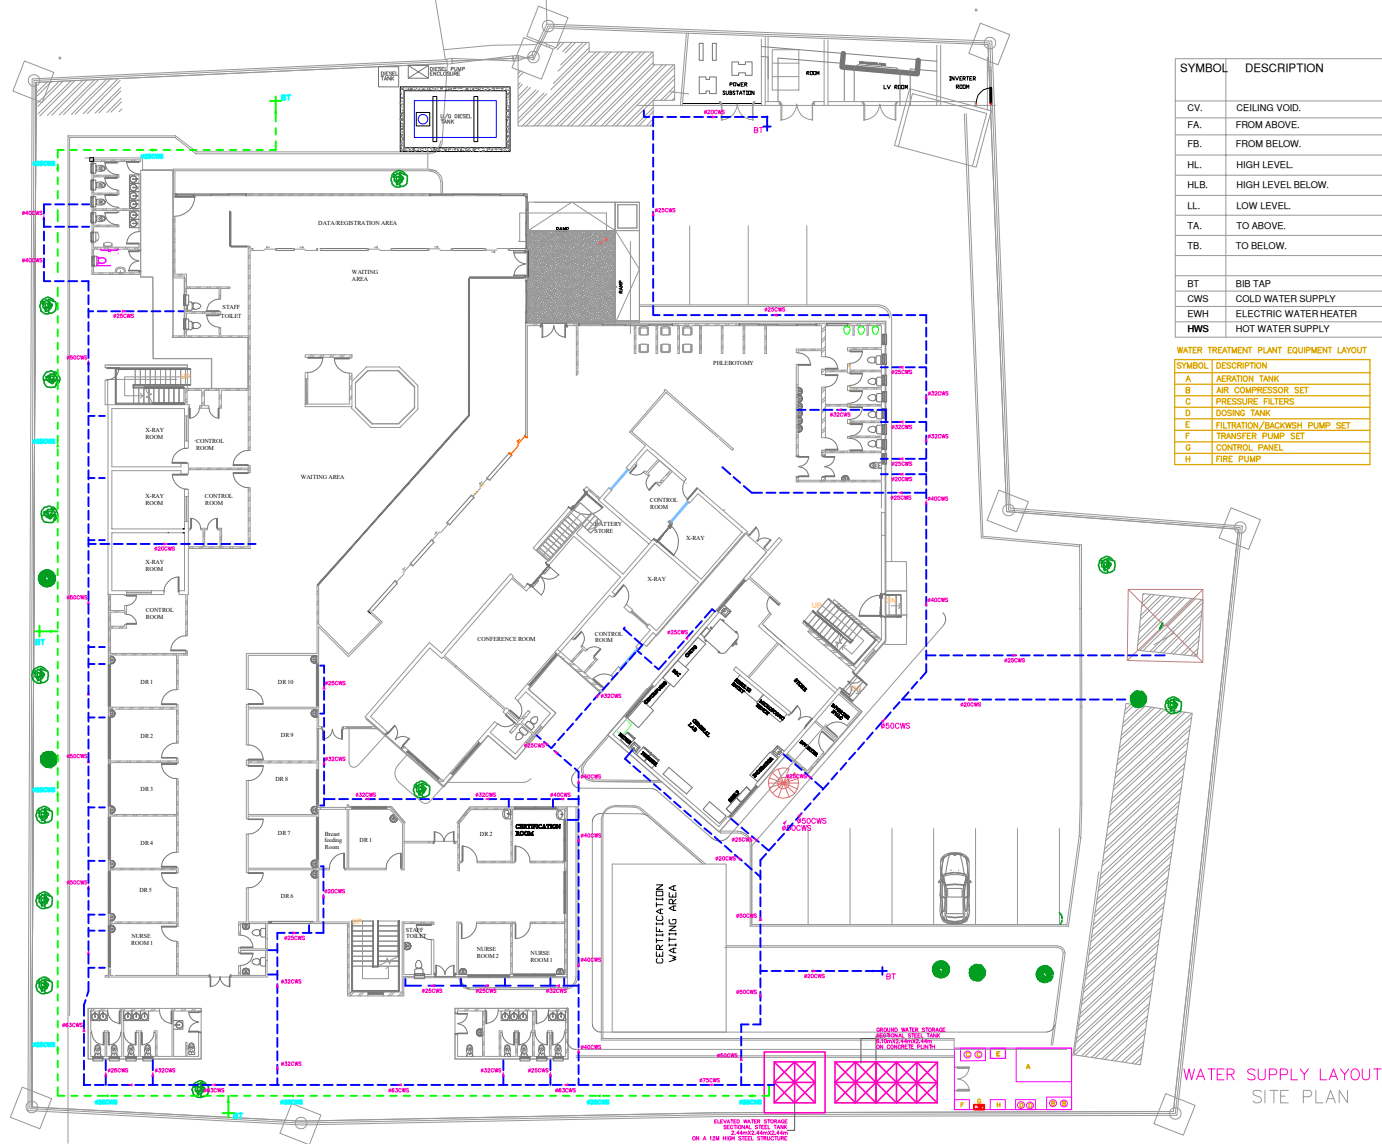
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SHEET CONTENT	GROUND FLOOR - WATER SUPPLY	SHEET NO.
SCALE CHECKED APPROVED	NIS QAW DATE P967/M/15	P M15 P967



SYMBOL	DESCRIPTION
CV.	CEILING VOID.
FA.	FROM ABOVE.
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SD	SOAP DISPENSER



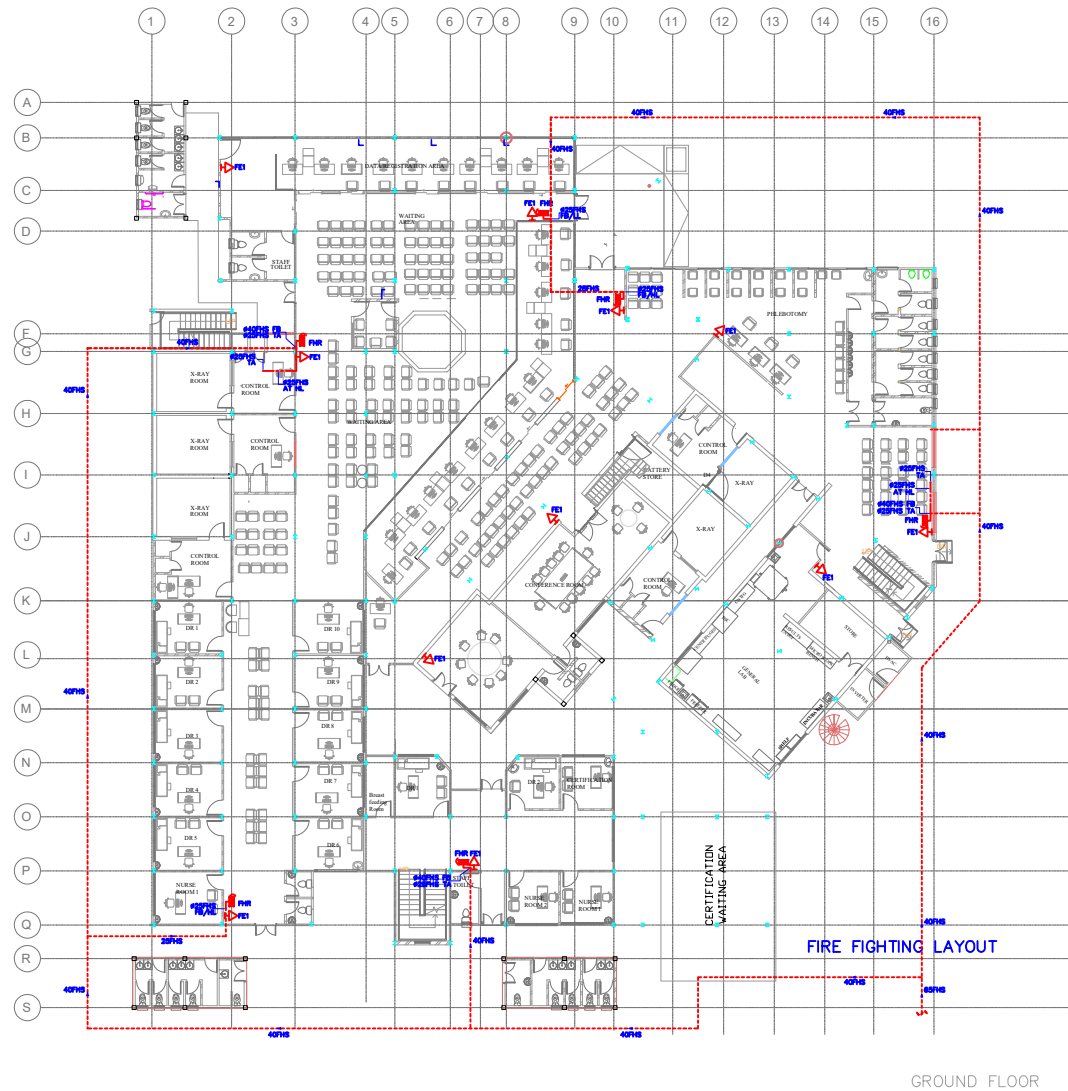


SYMBOL	DESCRIPTION
FA.	FROM ABOVE.
FB.	FROM BELOW.
LL.	LOW LEVEL.
TA.	TO ABOVE.
TB.	TO BELOW.
AAV	AUTOMATIC AIR-RELEASE VALVE
DRS	DRY RISER SERVICE
FB	FIRE BLANKET
FE1	PORTABLE FIRE EXTINGUISHER 6KG DRY POWDER
FHR	FIRE HOSE REEL
FHS	FIRE HOSE REEL SERVICES

GROUND FLOOR

NO.	REVISIONS	DATE	BY
1	ISSUED FOR REVIEW	24 MAR 20	AA
2	ISSUED FOR REVIEW	20 MAY 20	QJW
3	ISSUED FOR REVIEW	28 JUNE 20	QJW
4	ISSUED FOR REVIEW	24 AUG 20	QJW
5	ISSUED FOR REVIEW	07 SEPT 20	QJW
6	ISSUED FOR REVIEW	16 SEPT 20	QJW

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 SPECIFICATIONS SHOWN ON THIS DRAWING.
 THE ARCHITECT'S OFFICE SHALL BE RESPONSIBLE FOR
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 SPECIFICATIONS SHOWN ON THIS DRAWING.

SHEET CONTENT	GROUND FLOOR - FIRE FIGHTING	SHEET NO.
SCALE: NS	FILE NAME: P967/M/18	P M18
CHECKED: QJW	DATE: 16 SEPT 20	PROJ. NO. P967
APPROVED: QJW	DATE: 16 SEPT 20	

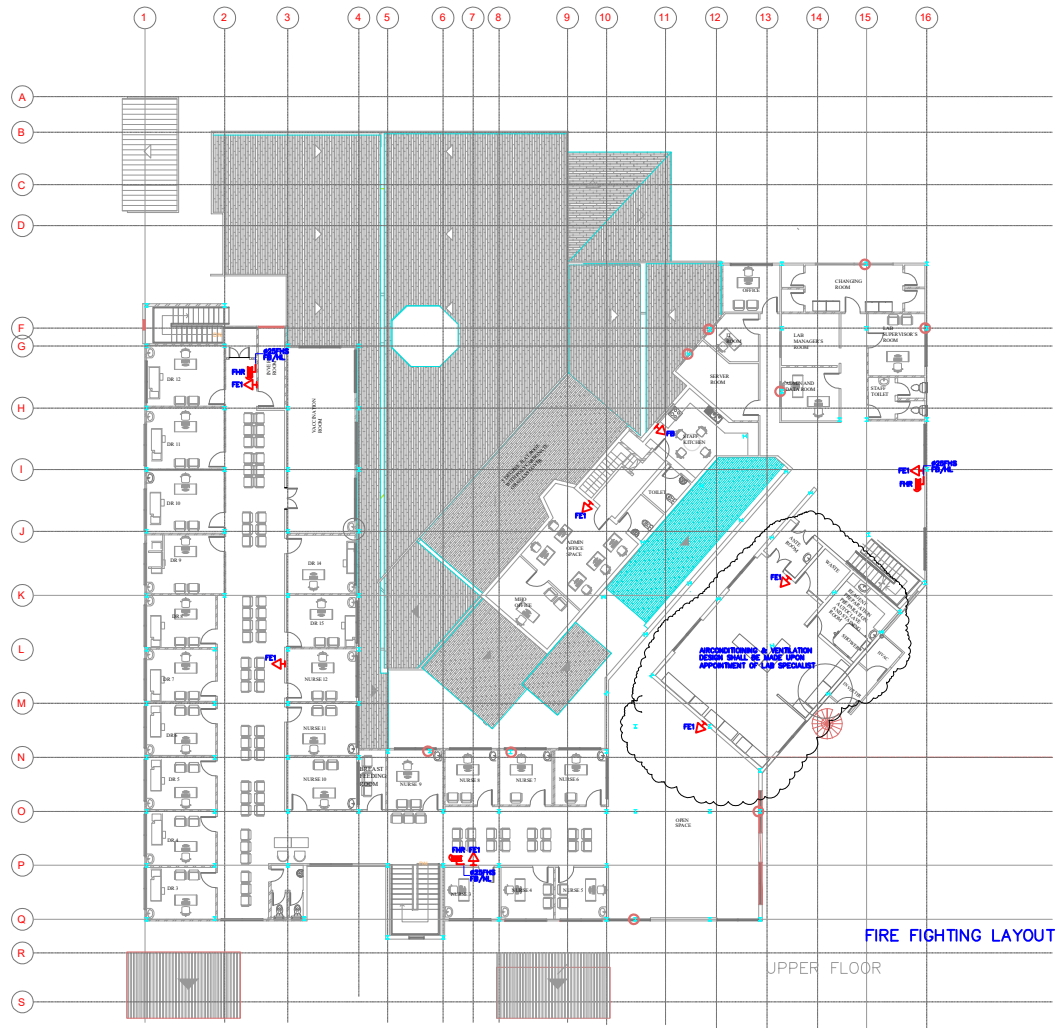


SYMBOL	DESCRIPTION
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AAV	AUTOMATIC AIR-RELEASE VALVE
DRS	DRY RISER SERVICE
FB	FIRE BLANKET
FE1	PORTABLE FIRE EXTINGUISHER 6KG DRY POWDER
FHR	FIRE HOSE REEL
FHS	FIRE HOSE REEL SERVICES

NO.	REVISIONS	DATE	BY
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2	ISSUED FOR REVIEW	20 MAY 20	CJW
3	ISSUED FOR REVIEW	20 JUNE 20	CJW
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BEFORE PROCEEDING. ALL DIMENSIONS ARE
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ARCHITECT/ENGINEER.

SHEET CONTENT	UPPER FLOOR - FIRE FIGHTING	SHEET NO.
SCALE	NS	P M19
CHECKED	CJW / ORAWN	FILE NAME
APPROVED	CJW / DATE	P967/M/19
		PROJ. NO. P967

NOTES

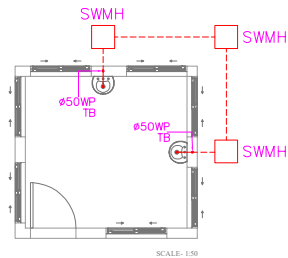


DOT ROOM
FLOOR PLAN



SPUTUM ROOM
FLOOR PLAN

SYMBOL	DESCRIPTION
CV.	CEILING VOID.
FA.	FROM ABOVE.
FB.	FROM BELOW.
HL.	HIGH LEVEL.
HLB.	HIGH LEVEL BELOW.
LL.	LOW LEVEL.
TA.	TO ABOVE.
TB.	TO BELOW.
FD.	FLOOR DRAIN.
RWO.	RAINWATER OUTLET.
RWP.	RAINWATER PIPE.
SAP.	SOAKAWAY PIT.
ST.	SEPTIC TANK.
SP.	SOIL PIPE.
SWP.	SOIL WASTE PIPE.
SWMH	
VC.	
VP.	
WMH	
WP.	

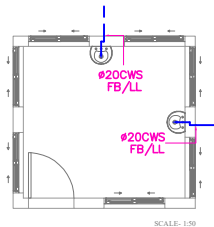

DOT ROOM
FLOOR PLAN



SPUTUM ROOM
FLOOR PLAN

NOTES

SYMBOL	DESCRIPTION
CV.	CEILING VOID.
FA.	FROM ABOVE.
FB.	FROM BELOW.
HL.	HIGH LEVEL.
HLB.	HIGH LEVEL BELOW.
LL.	LOW LEVEL.
TA.	TO ABOVE.
TB.	TO BELOW.
CWS.	COLD WATER SUPPLY
EWB.	ELECTRIC WATER HEATER
HD.	HAND DRYER
HWS.	HOT WATER SUPPLY
SD.	SOAP DISPENSER

NOTES

NOTES:

AIR CONDITIONING AND VENTILATION SERVICES

1. REFRIGERANT PIPEWORK THROUGH WALL & SLABING SHALL BE PROTECTED WITH CORRUGATED PVC SLEEVES.
2. INSULATED REFRIGERANT PIPEWORK SHALL BE GENERALLY BE PROTECTED VINYL TAPE
3. CONDENSATE PIPEWORK SHALL BE 32mm AND INSULATED
4. CONDENSATE DRAIN CONNECTIONS TO WP SHALL BE WITH DOUBLE TRAP
5. CONDENSATE SHALL BE DISCHARGED TO STORM DRAINAGE. WHERE THIS IS NOT FEASIBLE, CONDENSATE SHALL BE DISCHARGED INTO PURPOSED CONDENSATE PIT (300x300 PIT FILLED WITH GRANITE)
6. OUTDOOR UNITS SHALL GENERALLY BE MOUNTED ON PURPOSE MADE BRACKET AT LOW LEVEL OR HIGH LEVEL AS INDICATED ON THE DRAWINGS.
7. OUTDOOR UNIT AT LOW LEVEL MAY ALSO BE MOUNTED ON CONCRETE PLINTH
8. ANTIVIBRATION MOUNTING SHALL BE PROVIDED FOR OUTDOOR UNIT

VENTILATION EQUIPMENT SCHEDULE

SYMBOL	DESCRIPTION	CAPACITY
WEF1	WALL EXTRACT FAN	76 l/s
IEF1	IN-DUCT EXTRACT FAN	90 l/s
IEF2	IN-DUCT EXTRACT FAN	113 l/s
IEF3	IN-DUCT EXTRACT FAN	190 l/s

SYMBOL	DESCRIPTION
FA.	FROM ABOVE.
FB.	FROM BELOW.
HL.	HIGH LEVEL.
HLB.	HIGH LEVEL BELOW.
LL.	LOW LEVEL.
TA.	TO ABOVE.
TB.	TO BELOW.
CSU	CEILING CASSETTE UNIT
CP	CONDENSATE PIPE
CU	CONDENSING UNIT
EG	EXTRACT VALVE
EL	EXTERNAL LOUVRE
FSU	FLOOR STANDING UNIT
IEF	IN-LINE EXTRACT FAN
RP	REFRIGERANT PIPE
WEF	WALL EXTRACT FAN
WSU	WALL SPLIT UNIT
WU	WALL UNIT (VRV)

AIR CONDITIONING EQUIPMENT SCHEDULE
BRAND NAME: LG


		WSU1	WSU2	WSU3	WSU4	CSU2	FSU
MODEL	INDOOR	S4-Q09WAQAL	S4-Q12JAQAL	S4-Q18JLQAL	S4-Q24K2QAL	ATNQ18GPLT1	ATNQ18GPLT1
	OUTDOOR					ATUQ18GPLY1	ATUQ18GPLY1
POWER SUPPLY		1Ph/50Hz/220V	1Ph/50Hz/220V	1Ph/50Hz/220V	1Ph/50Hz/220V	1Ph/50Hz/220V	3Ph/50Hz/400V
COOLING CAP. (Max)		2.64kW	3.52kW	5.28kW	6.45kW	5.36kW	13.5kW
MAX. POWER INPUT		1.27kW	1.35kW	1.95kW	2.6kW	1.71kW	4.65kW
PIPING Size (Liquid/Gas)		Ø6.35mm/9.52mm	Ø6.35mm/9.52mm	Ø6.35mm/12.70mm	Ø6.35mm/12.70mm	Ø6.35mm/12.70mm	Ø9.52mm/19.05mm
REFRIGERANT TYPE		R410A	R410A	R410A	R410A	R410A	R410A

NB:
INFORMATION ON REFRIGERANT PIPING AND POWER TO BE CONFIRMED
WHEN EQUIPMENT ARE PROCURED.

NO.	REVISIONS	DATE	BY
1	ISSUED FOR REVIEW	24 MAR 20	IAA
2	ISSUED FOR REVIEW	20 MAY 20	QJW
3	ISSUED FOR REVIEW	28 JUNE 20	QJW
4	ISSUED FOR REVIEW	24 AUG 20	QJW
5	ISSUED FOR REVIEW	07 SEPT 20	QJW
6	ISSUED FOR REVIEW	16 SEPT 20	QJW

NO NET SCALE. ALL DIMENSIONS MUST
CHECK ON SITE.
ALL DIMENSIONS AND QUANTITIES
SHOWN, AND NOTED AS LOCATED NOTES
MAY BE REFERRED TO THE ARCHITECT'S
GENERAL PARTICULARS AND REVISIONS TO WHATEVER
PLOT NUMBER.
IF THE DRAWING IS FORWARDED AND NOT
NOTED AS LOCATED OR USED IN ANY WAY
WITHOUT THE AUTHORITY OF THE
ARCHITECT/ENGINEER.

NOTES

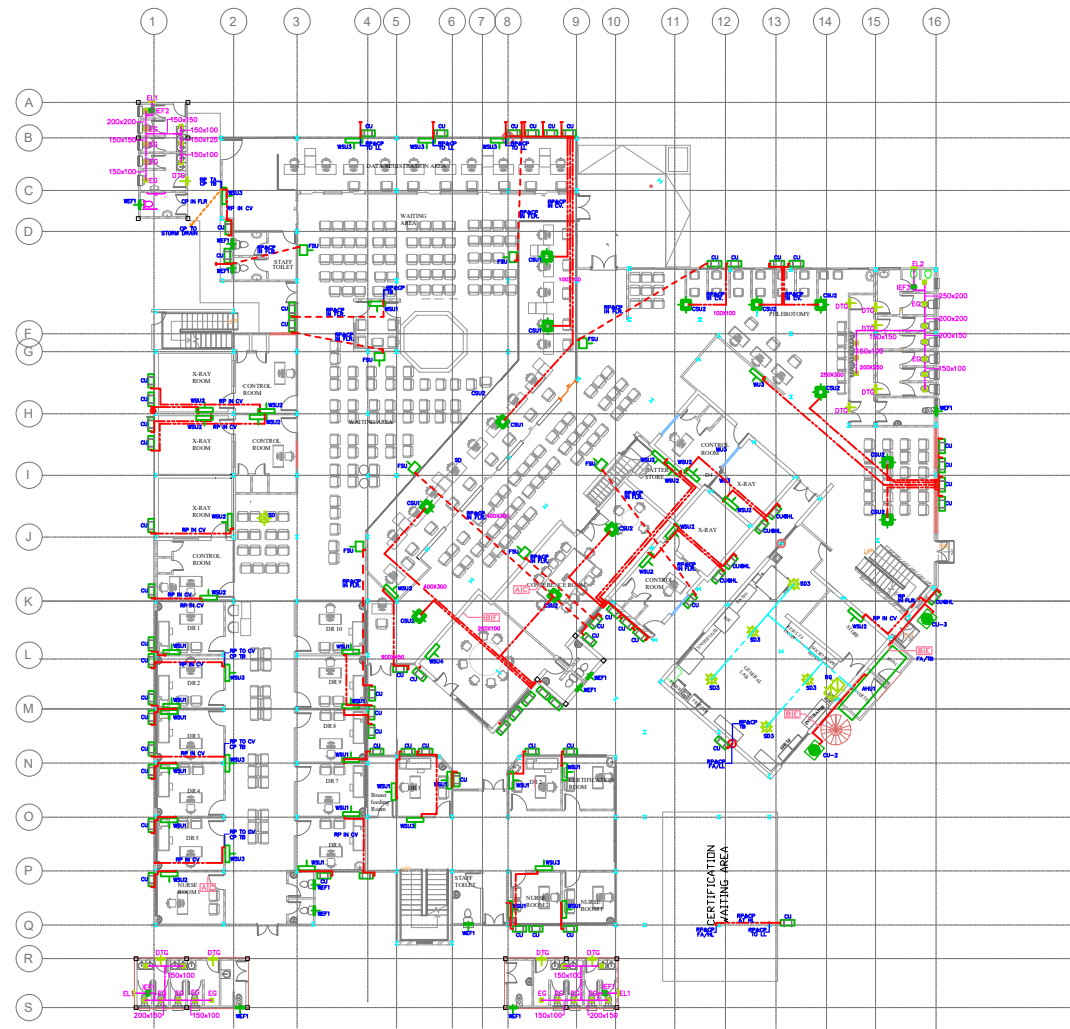


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1/150	1/150

AIR CONDITIONING & VENTILATION LAYOUT
GROUND FLOOR

NO.	REVISIONS	DATE	BY
1	ISSUED FOR REVIEW	24 MAR 20	PA
2	ISSUED FOR REVIEW	20 MAY 20	CJM
3	ISSUED FOR REVIEW	26 JUN 20	CJM
4	ISSUED FOR REVIEW	24 AUG 20	CJM
5	ISSUED FOR REVIEW	01 SEP 20	CJM
6	ISSUED FOR REVIEW	15 SEP 20	CJM

DO NOT SCALE. ALL DIMENSIONS MUST
CHECK ON SITE.
ALL DIMENSIONS AND SPECIFICATIONS
SHOWN ARE APPROVED BY THE ARCHITECT.
ANY CHANGES MUST BE APPROVED BY THE
ARCHITECT.
DO NOT SCALE. ALL DIMENSIONS MUST
CHECK ON SITE.
ALL DIMENSIONS AND SPECIFICATIONS
SHOWN ARE APPROVED BY THE ARCHITECT.
ANY CHANGES MUST BE APPROVED BY THE
ARCHITECT.

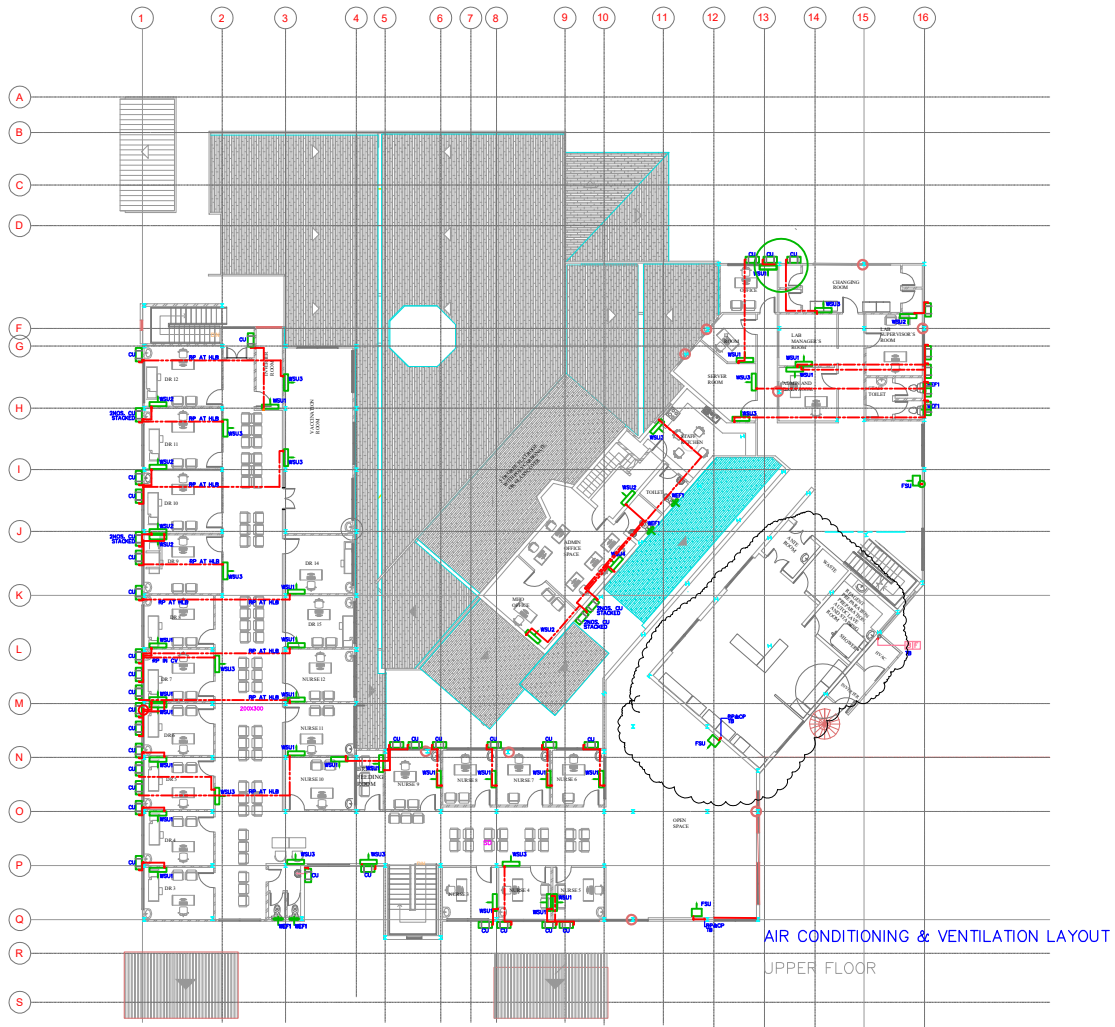

SYMBOL	DESCRIPTION
CK	CEILING VENT
FAC	FRESH AIR INLET
FA	FRESH AIR OUTLET
HL	HIGH LEVEL
HBL	HIGH LEVEL BLIND
LL	LOW LEVEL
TA	TO ABOVE
TB	TO BELOW
AP	ACCESS PANEL
CCU	CEILING CONCEALED UNIT
CA	CEILING AIR OUTLET
CU	CEILING AIR INLET UNIT
CU	CONDENSING UNIT (SPLIT)
CU-MR	CONDENSING UNIT (MR)
CP	CONDENSATE PUMP
DTG	DOOR TRANSFER GRILLE
EL	EXTRINSIC COUPLER
EC	EXTRACT CHILL
ET	EXTRACT VENT
FAU	FRESH AIR UNIT
FPU	FLOOR STANDING UNIT
HE	HIGH EXTRACT VENT
HC	HIGH EXTRACT CHILL
RP	REFRIGERANT PUMP
SD	SPLIT SYSTEM
WBT	WALL BRACKET UNIT
WBL	WALL MOUNTED SPLIT UNIT
WBT	WALL MOUNTED UNIT (SPLIT)


NO.	REVISIONS	DATE	BY
1	ISSUED FOR REVIEW	24 MAR 23	AW
2	ISSUED FOR REVIEW	24 MAY 23	QJW
3	ISSUED FOR REVIEW	28 JUNE 23	QJW
4	ISSUED FOR REVIEW	24 JUL 23	QJW
5	ISSUED FOR REVIEW	01 SEPT. 23	QJW
6	ISSUED FOR REVIEW	15 SEPT. 23	QJW

DO NOT SCALE. ALL CONTRACTORS MUST
CHECK ON SITE.
1. ALL DIMENSIONS AND INFORMATION
PROVIDED. ANY AMBIGUITY OR DISCREPANCY
MAY BE ATTRIBUTED TO THE ARCHITECT.
2. THE CONTRACTOR SHALL BE RESPONSIBLE FOR
OBTAINING ALL NECESSARY PERMITS AND
NOT BE DISBURSED IN ANY MANNER BY
THE ARCHITECT/ENGINEER.

SHEET CONTENT	UPPER FLOOR - AC & VENT	SHEET NO.
SCALE: NS	CHECKED: QJW (DRAWN)	P M24
APPROVED: QJW (DATE)	FILE NAME: P867/M24	PROJ. NO.: P867

NOTES

SYMBOL	DESCRIPTION
CV.	CEILING VOID.
FA.	FROM ABOVE.
FB.	FROM BELOW.
HL.	HIGH LEVEL.
HLB.	HIGH LEVEL BELOW.
LL.	LOW LEVEL.
TA.	TO ABOVE.
TB.	TO BELOW.
CWS.	COLD WATER SUPPLY
EWB.	ELECTRIC WATER HEATER
HD.	HAND DRYER
HWS.	HOT WATER SUPPLY
SD.	SOAP DISPENSER

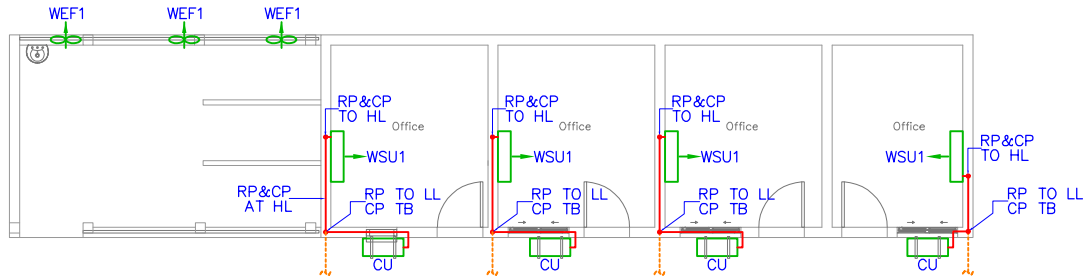

SPUTUM ROOM
FLOOR PLAN

SCALE: 1:50